

Perspective Images

Issued under the Environmental Planning and Assessment Act 1979

**Approved Application No: DA 10132** 









Stanton Dahl & Associates Physicinted. ABN: 32 002 28: Normated Architects; D.P Stanton 3642, S.M Evans 76

Stanton Dahl Architects

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All dimensions to be verified on site and any discrepancies referred to architect for determin

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Rev	Issue	Date
01	Revised Architectural Set	26/11/19
02	Revised Architectural Set	06/12/19
03	Revised Architectural Set	18/12/19
04	DA Re-Issue	17/01/20
05	DA Re-Issue (Garbage Room Redesign)	31/03/20

Architecture Project managemen Interior design









## Mono Constructions

Residential Apartment Building

56 Beane Street, Gosford, NSW

Drawn; jok/at/mc/e Checked; jok/ at Plot date: 1/4/20

Plot date; 1/4/20

Scale: as noted 0

Project No; 2421.19

Drawing No; Revis
A001 05

Perspective Images (1 of 2)



Perspective Images

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**Approved Application No: DA 10132** 



Sheet No: 2 of 48









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Architecture Interior design









## **Mono Constructions**

Residential Apartment Building

56 Beane Street, Gosford, NSW

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Scale; as noted @ Al

2421.19

Drawing No; A002


Perspective Images (2 of





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- Gosford Hospital (500m)
- Medical Centre (70m)
- Bus @ Hills Street (70m)
- Gosford Town Centre (200m)
- Rumbalara Reserve (100m)

✓ Gosford Train Station (230m)

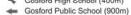Gosford High School (400m)

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Residential Apartment Building

56 Beane Street, Gosford, NSW


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2421.19

A003 04

Site & Block Analysis





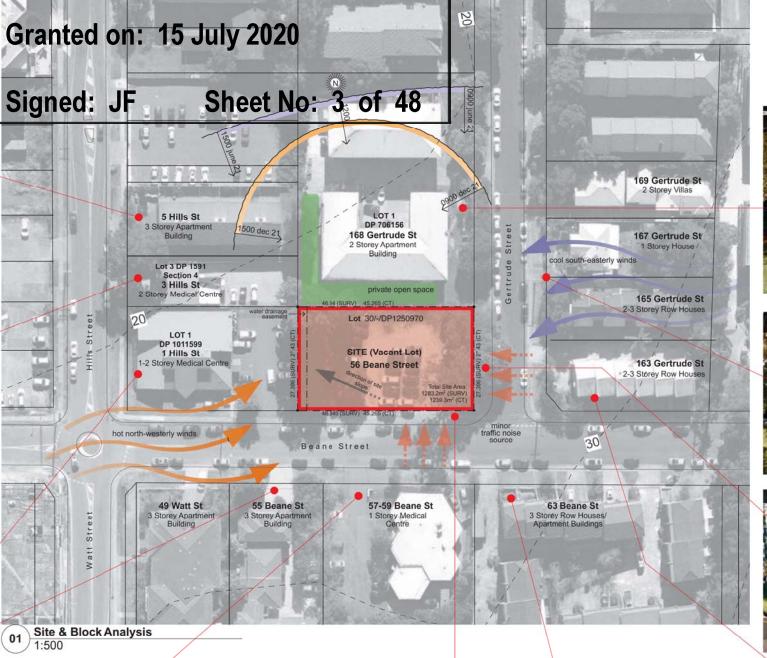


















**Building Envelope Diagram** 



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Granted on: 15 July 2020



Stanton Dahl & Associates Pty Limited ABIN 12 002 281
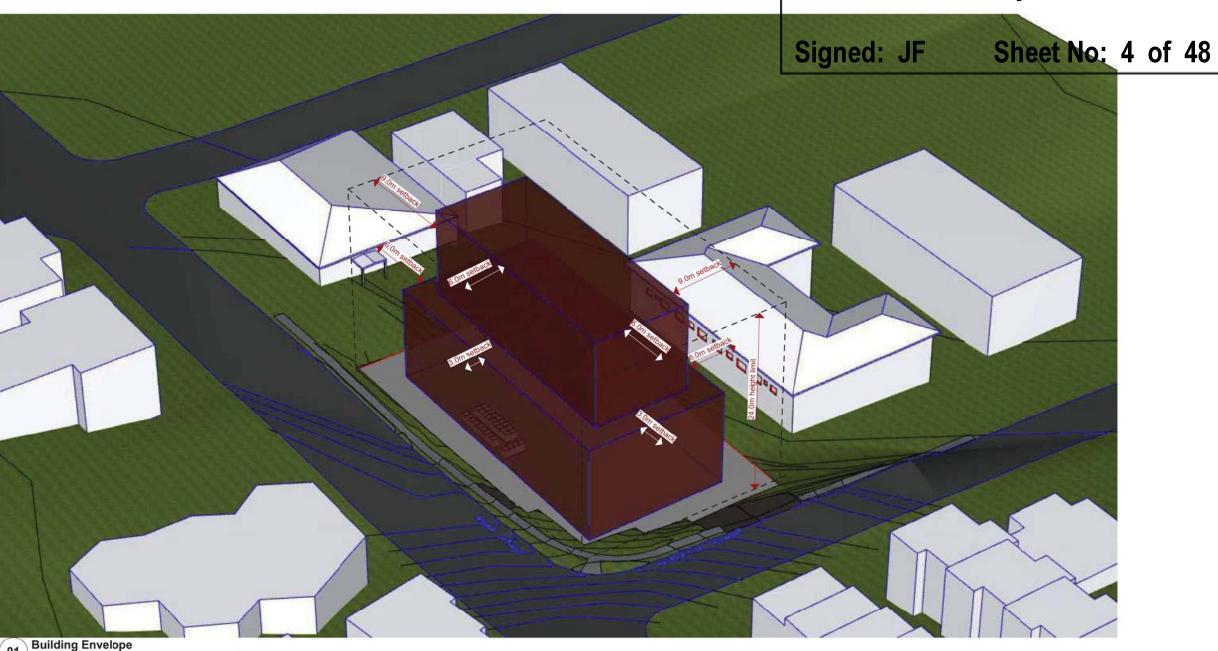
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Architecture Project management Interior design







Family & Community Services Land & Housing Corporation



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Residential Apartment Building

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56 Beane Street, Gosford, NSW


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Scale; as noted @ Al

Project No; 2421.19

Drawing No; Rev

Building Envelope Diagram

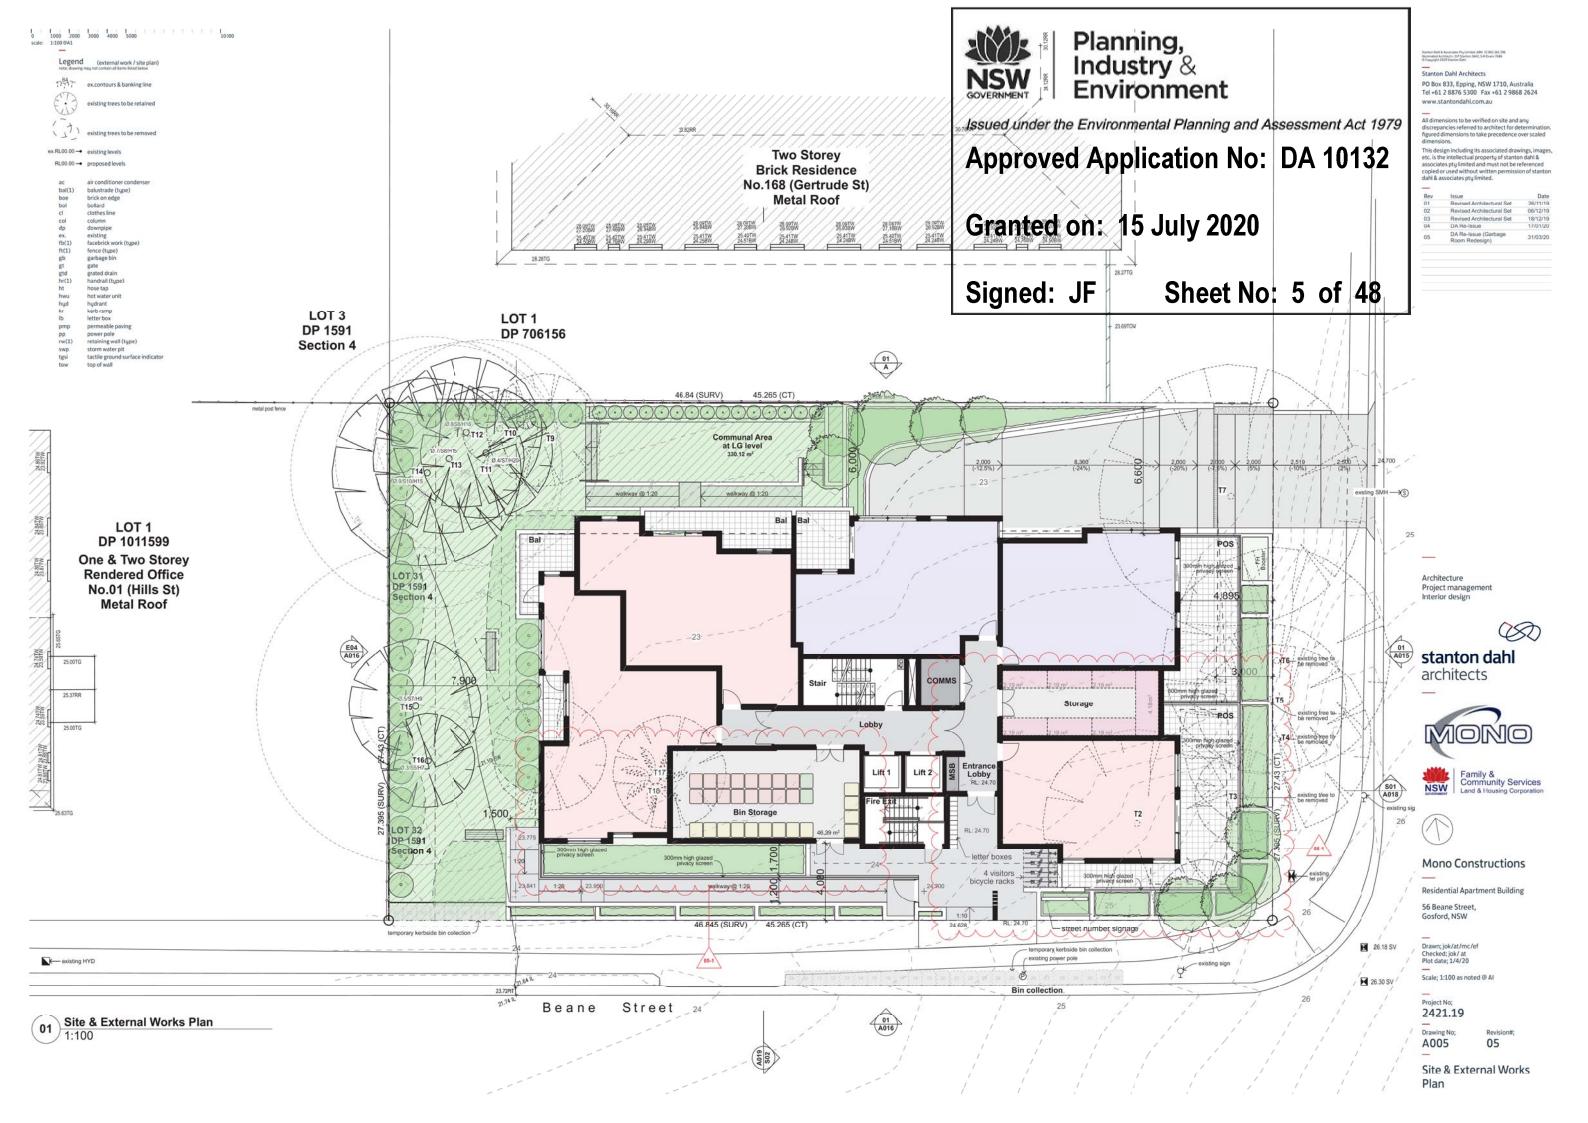

	DEV	ELOPMENT DATA					
ADDRESS		56-58 Beane Street,	Gosford				
SITE AREA	1,284m2						
NUMBER OF EXISTING LOTS	Lots 31 & 32 DP1591						
FSR* 0:5 bonus FSR	Pi	Max. FSR 2.5:1 (3, roposed FSR 2.376:1 (		)			
	Lower Ground		m2				
	Level 1	471.01	m2				
	Level 2	557.88	m2				
GFA*	Level 3	557.88	m2				
GFA	Level 4	557.88	m2				
	Level 5	302.12	m2				
	Level 6	302.12	m2				
	Level 7	302.12	m2				
	TOTAL	3,051.01	m2				
	*GFA measured to inner services & voids.			uding lifts, stairs,			
	Lower Ground	789.71	m2				
	Level 1	559.48	m2				
	Level 2	627.92	m2				
	Level 3	627.92	m2				
20.02 EUL V	Level 4	627.92	m2				
Total Build Area	Level 5	359.60	m2				
	Level 6	360.09	m2				
	Level 7	360.09	m2				
	TOTAL	4,312.73	m2				
-	*Total Build Area measure stairs, services & voids.	ed to outer face of exter	nal enclosin	g wall, including lifts			
	Bedroom No.	TOTAL					
YIELD	1 Bed Unit	21					
11220	2 Bed Unit	20					
	TOTAL	41					
NUMBER OF	Proposed Residential Ap-	artment Building (x 41 L	Inits) + Low	er ground Parking			

	Control	Require	ement	Proposed	
BUILDING HEIGHT	GOSFORD CITY CENTRE LEP	ORD CITY CENTRE LEP max. 24m		24m	
PARKING	ARHSEPP	21 x 1B @ 0.4 space = 8.4 20 x 2B @ 0.5 spaces = 10		19 spaces (required 18.4)	
Motorcycle& Bicycles	GOSFORD CITY CENTRE DCP	Motorcycles 41/15 = 2.7 Bicycles 41/3 = 13.6 Residents 41/12 = 3.4 Visitors		3 spaces 14 spaces 4 spaces	
		Front (street)	3m	complies	
SETBACKS	GOSFORD CITY CENTRE DCP	Side	6m	complies	
		Rear	6m	complies	
LANDSCAPE AREA	ADG	min. 25% of site area (321m2)		403m2 (31.4% of site area)	
DEEP SOIL	DCP	min. 7% of site area (90m2)		296m2 (23% of site area)	
COMMON AREA	DCP	Communal open space has a minimum area equal to 25% of the site (321m2)		330.20m2 (25.7% of site area)	
CROSS VENTILATION	ADG	At least 60% of apartments are naturally cross ventilated in the first nine storeys of the building. (16.8 units)		26 Units (63.4%)	
SOLAR ACCESS	ADG	Living rooms an spaces of at of apartments receive a mi hours direct sur 9 am an	t least 70% in a building nimum of 3 nlight between	29 Units (70%)	

DWELLING BREAK DESCRIPTION		ISSUE		COMMENT
UNIT 101 (Adaptable)		IGGOL		COMMENT
2 BED				
AREA = 79.89m2				
POS = 11.82m2 STORAGE = 6.67m3	(inside the unit)			
UNIT 102 (Adaptable)	product the dring			
2 BED				
AREA = 74.72m2 POS = 11.60m2				
STORAGE = 4.60m3	(inside the unit)			
UNIT 103 (Adaptable)	firemental management			
1 BED				
AREA = 64.40m2				
POS = 8.69m2 STORAGE = 4.10m3	(inside the unit)			
UNIT 104 (Adaptable)	turner are stord			
1 BED				
AREA = 61.76m2 POS = 27.40m2				
STORAGE = 3.57m3	(inside the unit)			
UNIT 105	<del></del>			
1 BED AREA = 54.69m2				
POS = 38.87m2				
STORAGE = 2.43m3	(inside the unit)			
UNIT 201 / 301 / 401				
2 BED AREA = 70.20m2	111	1 1 1	1111	1111
POS = 18.57m2				3000
STORAGE = 4.78m3	(inside the unit)			
UNIT 202 / 302 / 402	ACULT TO			
1 BED AREA = 52.98m2				
POS = 8.10m2				
STORAGE = 3.57m3	(inside the unit)			
UNIT 203 / 303 / 403				
2 RED AREA = 72.11m2				
POS = 10.23m2				
STORAGE = 4.73m3	(inside the unit)			
UNIT 204 / 304 / 404 1 BED				
1 BED AREA = 53.14m2				
POS = 8.69m2				
STORAGE = 4.48m3	(inside the unit)			
UNIT 205 / 305 / 405 1 BED				
AREA = 53.14m2				
POS = 8.69m2				
STORAGE = 4.48m3 UNIT 206 / 306 / 406	(inside the unit)			
2 BED				
AREA = 72.08m2				
POS = 10.01m2				
STORAGE = 4.65m3	(inside the unit)			
UNIT 207 / 307 / 407				
1 BED				
AREA = 51.07m2 POS = 8.13m2 / 8.54m2 / 8.54	Im2			
STORAGE = 3.53m3	(inside the unit)			
UNIT 208 / 308 / 408	, and any			
2 BED				
AREA = 71.12m2				
POS = 14.41m2				
STORAGE = 6.56m3	(inside the unit)			
UNIT 501 (Adaptable)	-			
2 BED				
AREA = 81.14m2				
CHINAL TAILURE				
POS = 10.36m2				
	(inside the unit)			
POS = 10.36m2	(inside the unit)			
POS = 10.36m2 STORAGE = 6.02m3	(inside the unit)			
POS = 10.36m2 STORAGE = 6.02m3 UNIT 502 / 602 / 702	(inside the unit)			
POS = 10.36m2 STORAGE = 6.02m3 UNIT 502 / 602 / 702 1 BED	(inside the unit)			
POS = 10.36m2 STORAGE = 6.02m3 UNIT 502 / 602 / 702 1 BED AREA = 56.70m2	(inside the unit)			
POS = 10.36m2 STORAGE = 6.02m3 UNIT 502 / 602 / 702 1 BED AREA = 56.70m2 POS = 8.40m2	Grande trie with			
POS = 10.36m2 STORAGE = 6.02m3 UNIT 502 / 602 / 702 1 BED AREA = 56.70m2 POS = 8.40m2 STORAGE = 6.91m3 UNIT 503 / 603 / 703 1 BED	Grande trie with			
POS = 10.36m2 STORAGE = 6.02m3 UNIT 502 / 602 / 702 1 BED AREA = 56.70m2 POS = 8.40m2 STORAGE = 6.91m3 UNIT 503 / 603 / 703	Grande trie with			
POS = 10.36m2 STORAGE = 6.02m3 UNIT 502 / 602 / 702 1 BED AREA = 56.70m2 POS = 8.40m2 STORAGE = 6.91m3 UNIT 503 / 603 / 703 1 BED	Grande trie with			
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POS = 10.36m2 STORAGE = 6.02m3 UNIT 502 / 602 / 702 1 BED AREA = 58.70m2 POS = 8.40m2 STORAGE = 6.91m3 UNIT 503 / 603 / 703 1 BED AREA = 56.70m2 POS = 8.40m2 STORAGE = 8.91m3 UNIT 504 2 BED AREA = 71.10m2	(inside the unit)			
POS = 10.36m2 STORAGE = 6.02m3 UNIT 502 / 602 / 702 1 BED AREA = 56.70m2 POS = 8.40m2 STORAGE = 6.91m3 UNIT 502 / 603 / 703 1 BED AREA = 56.70m2 POS = 8.40m2 STORAGE = 6.91m3 UNIT 504 2 BED	(inside the unit)			
POS = 10.36m2 STORAGE = 6.02m3 UNIT 502 / 602 / 702 1 BED AREA = 56.70m2 POS = 8.40m2 STORAGE = 6.91m3 UNIT 503 / 603 / 703 1 BED AREA = 56.70m2 POS = 8.40m2 STORAGE = 6.91m3 UNIT 504 2 BED AREA = 71.10m2 POS = 10.08m2 STORAGE = 4.80m3	(inside the unit)			
POS = 10.36m2 STORAGE = 6.02m3 UNIT 502 / 502 / 702 1 BED AREA = 56.70m2 POS = 8.40m2 STORAGE = 6.91m3 UNIT 503 / 603 / 703 1 BED AREA = 56.70m2 POS = 8.40m2 STORAGE = 6.91m3 UNIT 504 2 STORAGE = 6.91m3 UNIT 504 AREA = 71.10m2 POS = 10.08m2	(inside the unit)			
POS = 10.36m2 STORAGE = 6.02m3 UNIT 502 / 602 / 702 1 BED AREA = 56.70m2 POS = 8.40m2 STORAGE = 6.91m3 UNIT 503 / 603 / 703 1 BED AREA = 56.70m2 POS = 8.40m2 STORAGE = 6.91m3 UNIT 504 2 BED AREA = 71.10m2 POS = 10.08m2 STORAGE = 4.80m3 UNIT 507 / 701 (Adaptable) 2 BED	(inside the unit)			
POS = 10.36m2 STORAGE = 6.02m3 MINT 502 / 602 / 702 1 BED AREA = 56.70m2 POS = 8.40m2 STORAGE = 6.91m3 UNIT 503 / 603 / 703 1 BED AREA = 56.70m2 POS = 8.40m2 STORAGE = 6.91m3 UNIT 504 2 BED AREA = 71.10m2 POS = 10.06m2 STORAGE = 4.80m3 UNIT 504 / 22 BED AREA = 71.10m2 POS = 10.06m2 STORAGE = 4.80m3 UNIT 501 / 701 (Adaptable) 2 BED AREA = 80.77m2	(inside the unit)			
POS = 10.36m2 STORAGE = 6.02m3 UNIT 502 / 602 / 702 1 BED AREA = 56.70m2 POS = 8.40m2 STORAGE = 6.91m3 UNIT 503 / 603 / 703 1 BED AREA = 56.70m2 POS = 8.40m2 STORAGE = 6.91m3 UNIT 504 2 BED AREA = 71.10m2 POS = 10.08m2 STORAGE = 4.80m3 UNIT 507 / 701 (Adaptable) 2 BED	(inside the unit)			
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POS = 10.36m2 STORAGE = 6.02m3 UNIT 502 / 502 / 702 1 BED AREA = 56.70m2 POS = 8.40m2 STORAGE = 6.91m3 UNIT 503 / 503 / 703 1 BED AREA = 56.70m2 POS = 8.40m2 STORAGE = 6.91m3 UNIT 504 2 BED UNIT 504 2 BED UNIT 504 2 BED AREA = 71.10m2 POS = 10.06m2 STORAGE = 4.80m3 UNIT 504 / 704 AREA = 77.17m2 POS = 10.06m2 STORAGE = 4.80m3 UNIT 601 / 701 (Adaptable) AREA = 80.77m2 POS = 16.21m2 STORAGE = 4.51m3 UNIT 604 / 704	(inside the unit)  (inside the unit)  (inside the unit)			
POS = 10.36m2 STORAGE = 6.02m3 UNIT 502 / 602 / 702 1 BED AREA = 56.70m2 POS = 8.40m2 STORAGE = 6.91m3 UNIT 503 / 603 / 703 1 BED AREA = 56.70m2 POS = 8.40m2 STORAGE = 6.91m3 UNIT 504 / 603 / 703 1 BED AREA = 56.70m2 POS = 8.40m2 STORAGE = 6.91m3 UNIT 504 2 BED STORAGE = 4.91m3 UNIT 504 2 BED STORAGE = 4.80m3 UNIT 501 / 701 (Adaptable) 2 BED STORAGE = 4.51m3 UNIT 501 / 701 (Adaptable) 2 BED STORAGE = 4.51m3 UNIT 504 / 704 2 BED	(inside the unit)  (inside the unit)  (inside the unit)			
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\*\* Storage claculations depict storage within the units only.

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> Architecture Project management Interior design









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Residential Apartment Building

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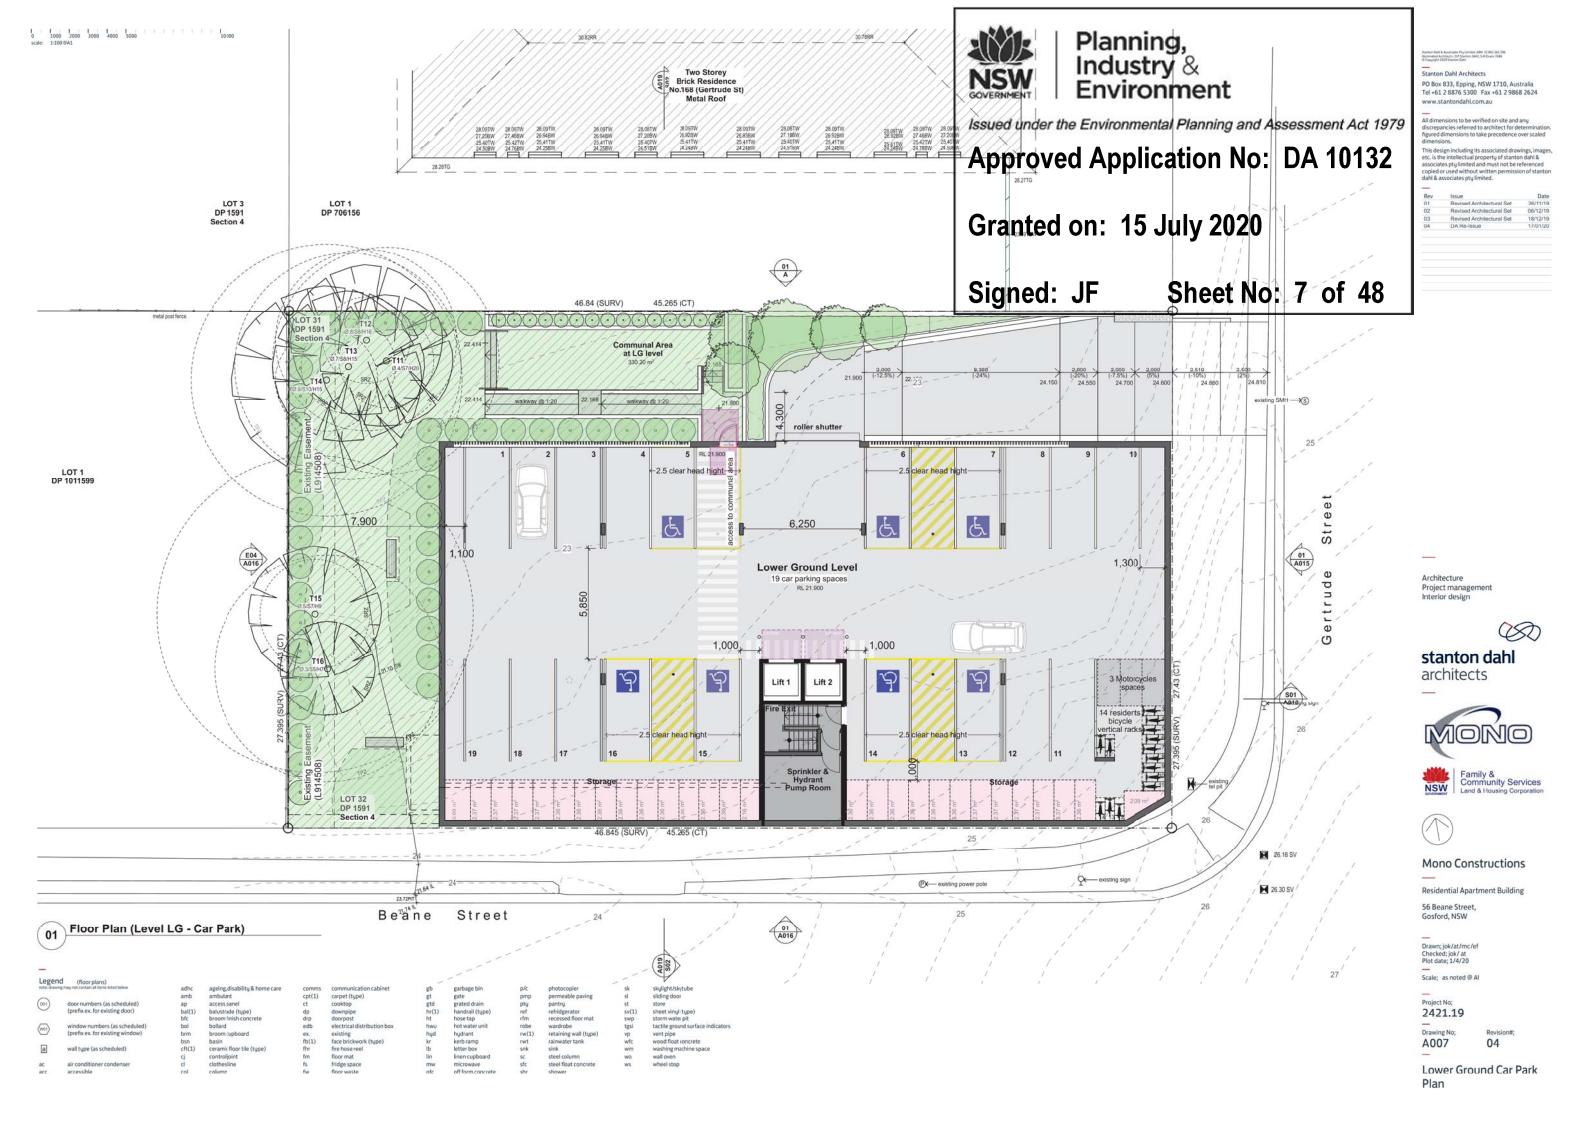
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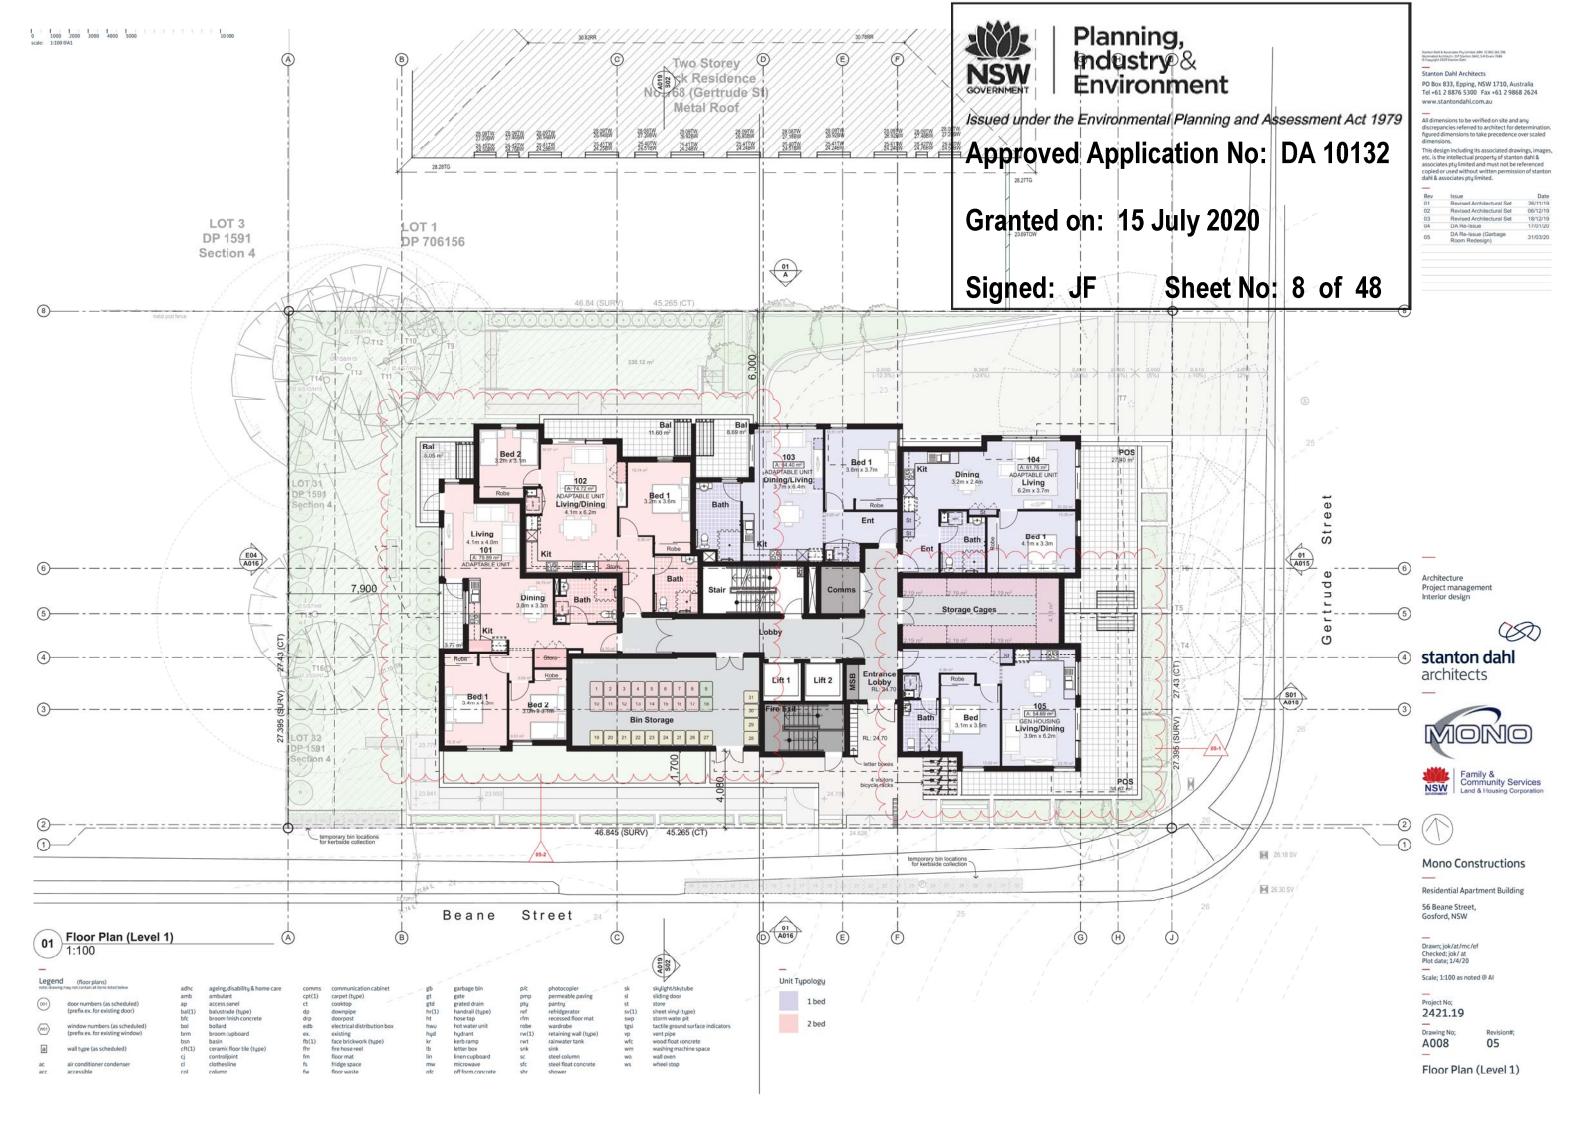
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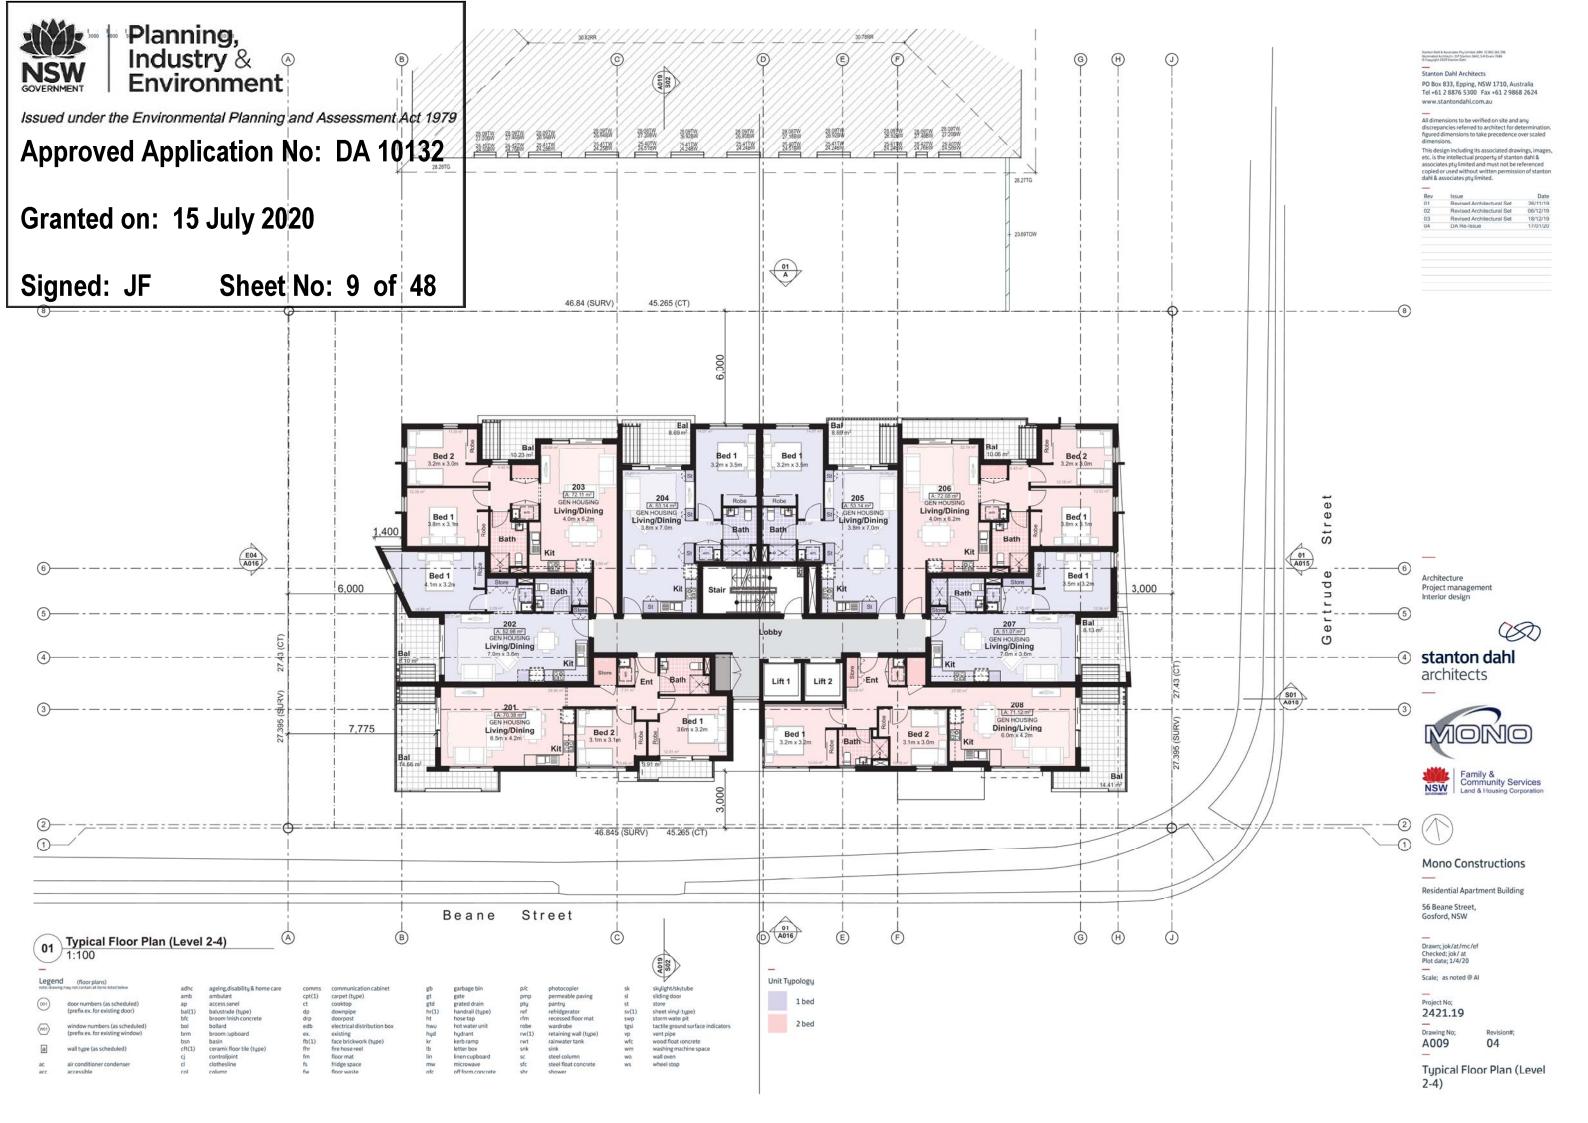
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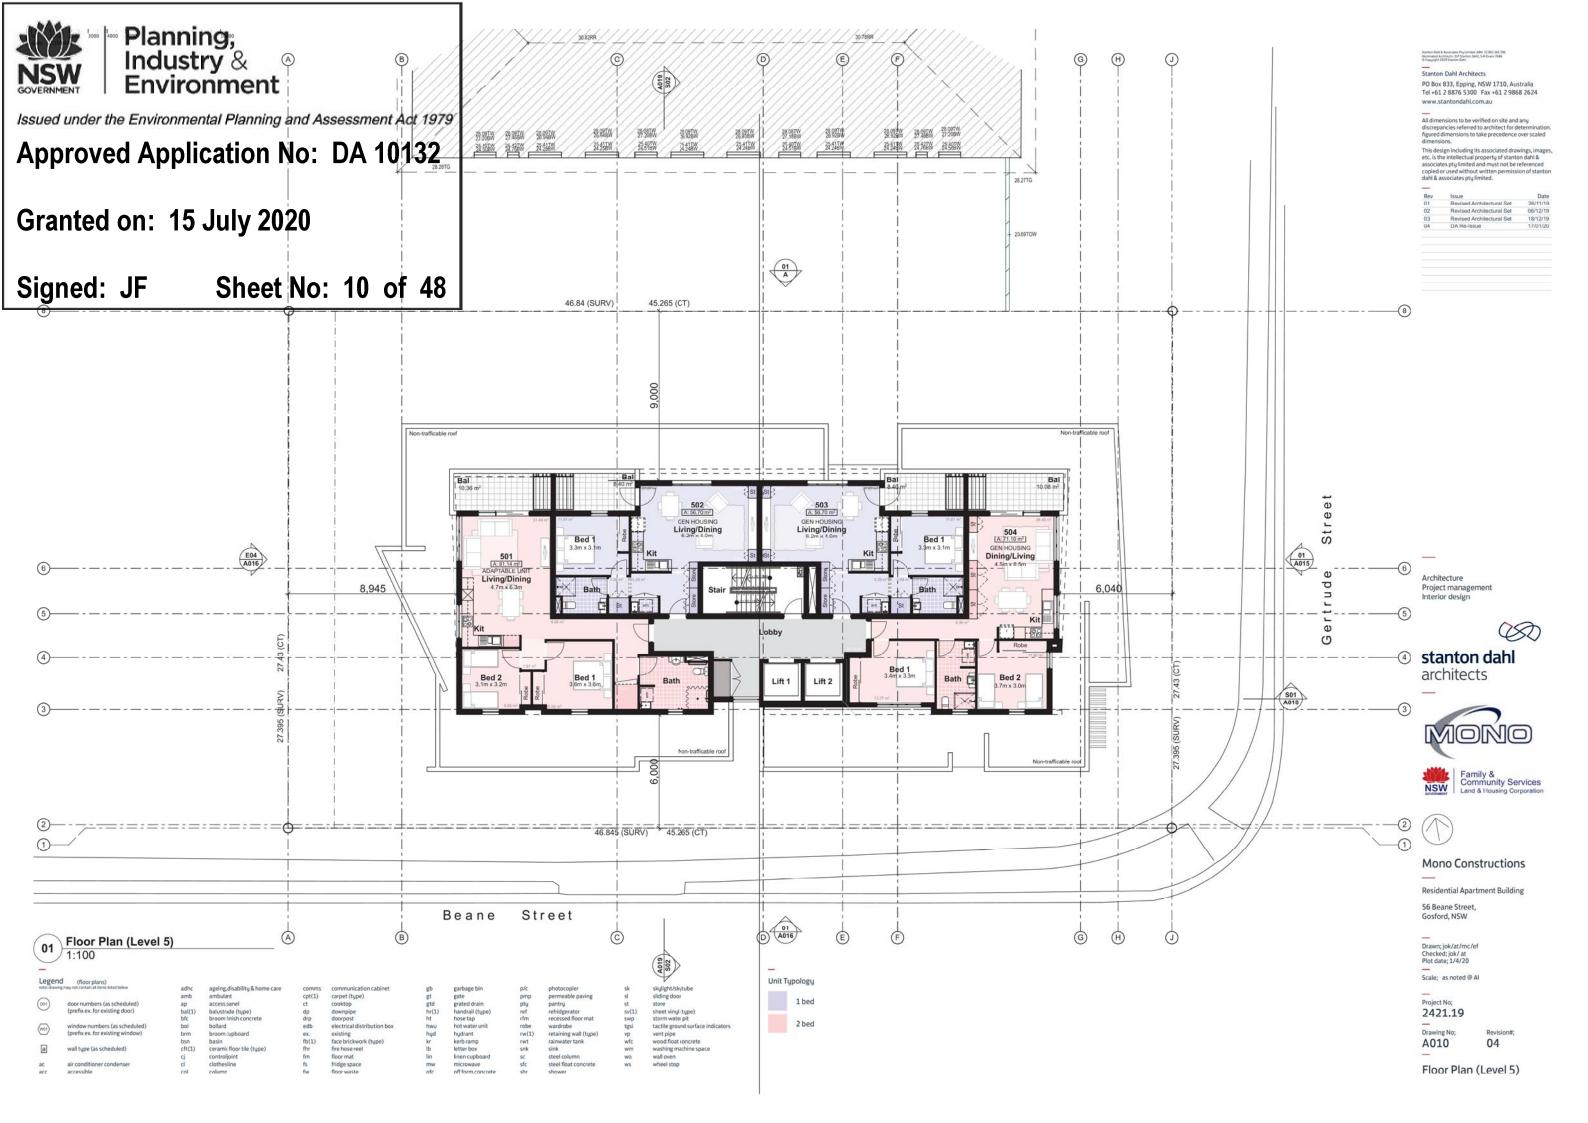
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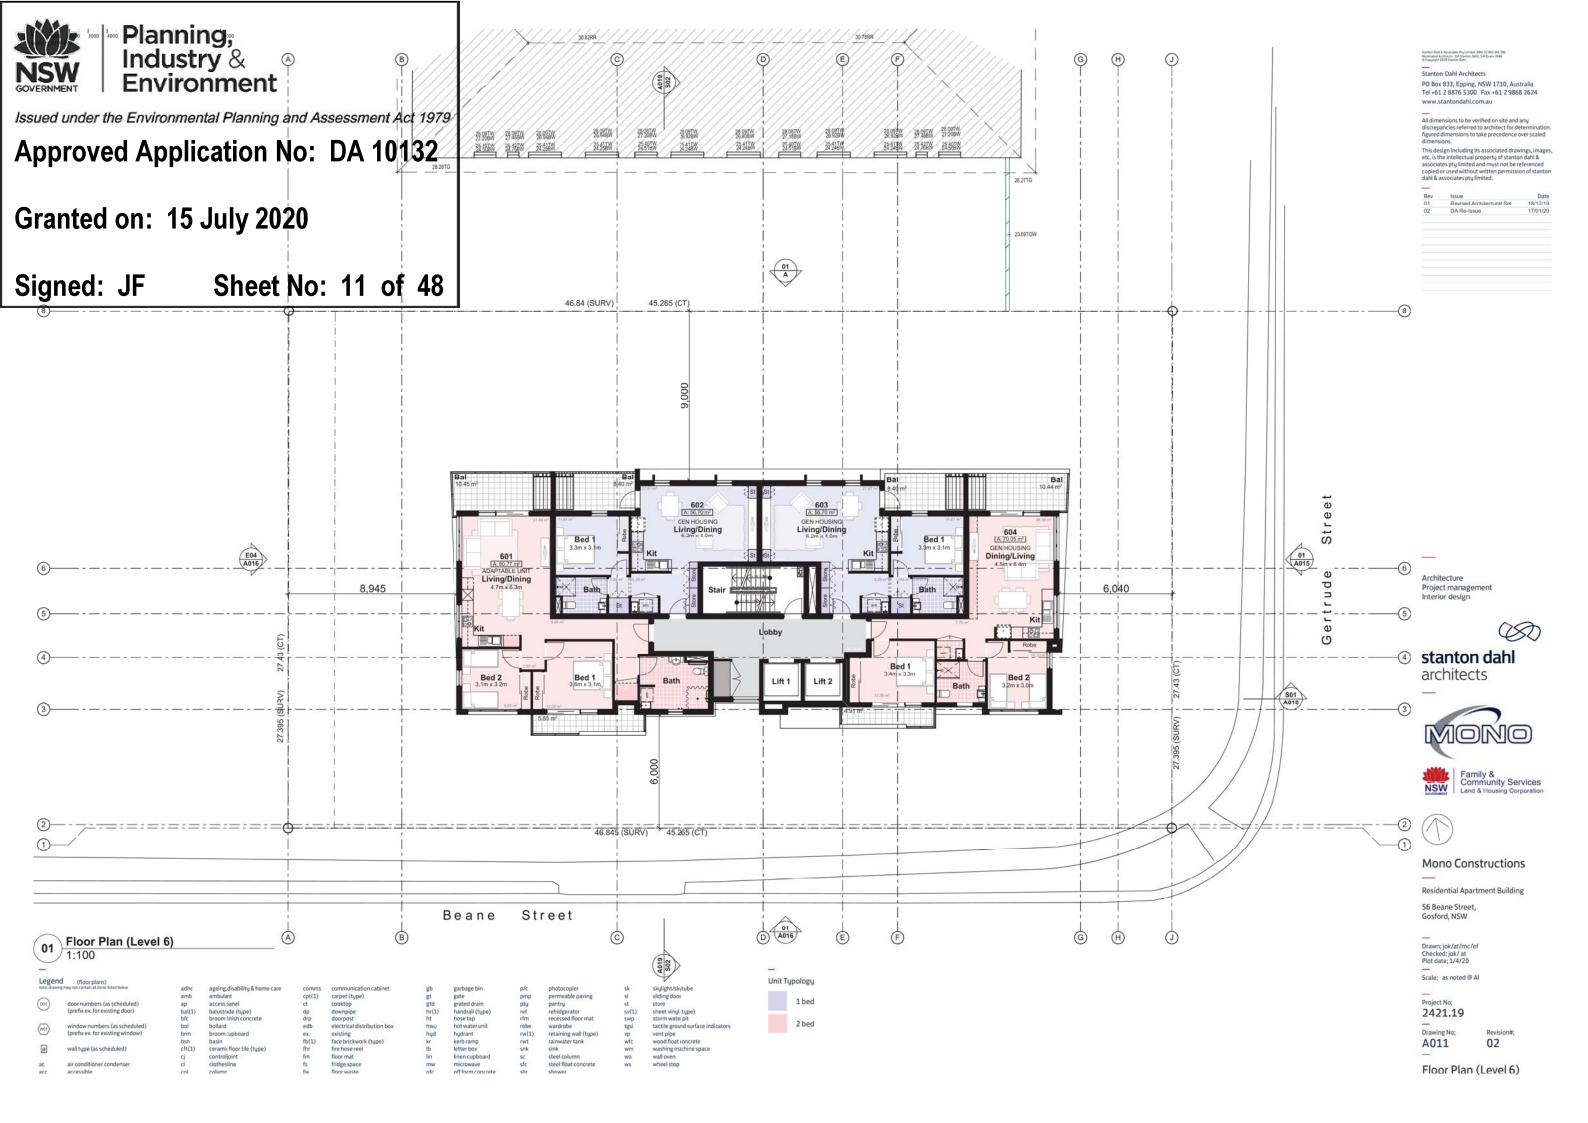
**Development Data** 













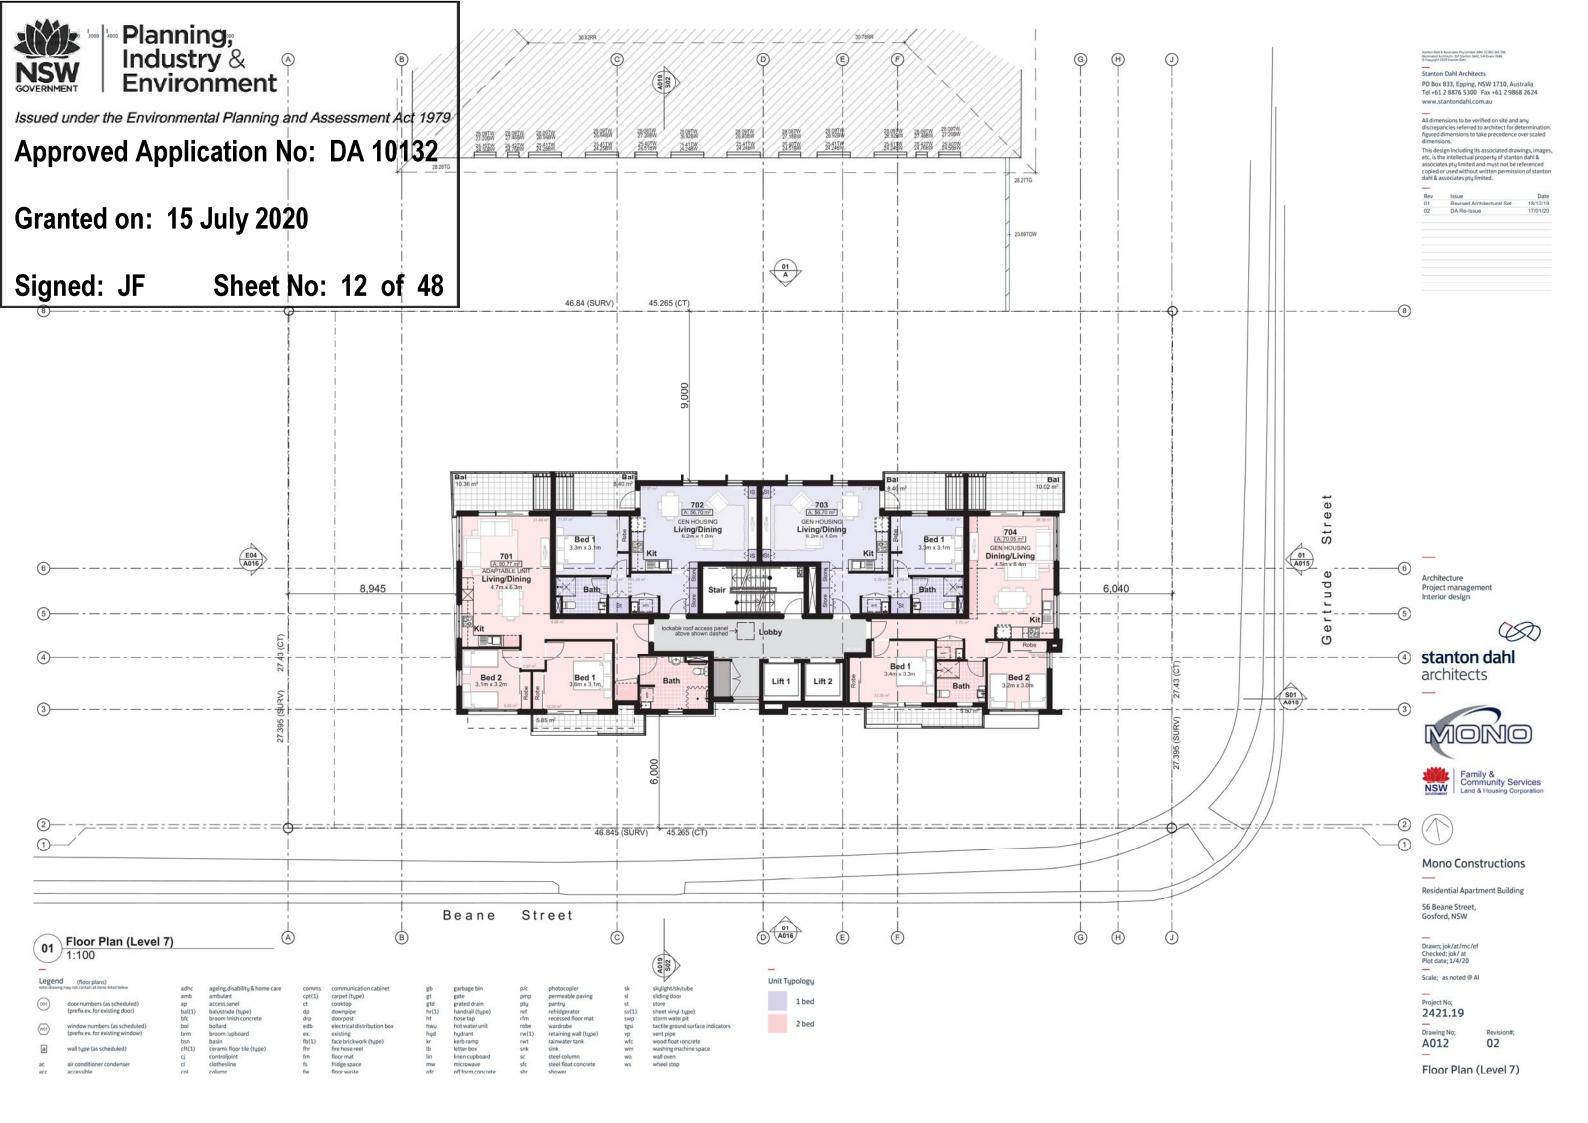

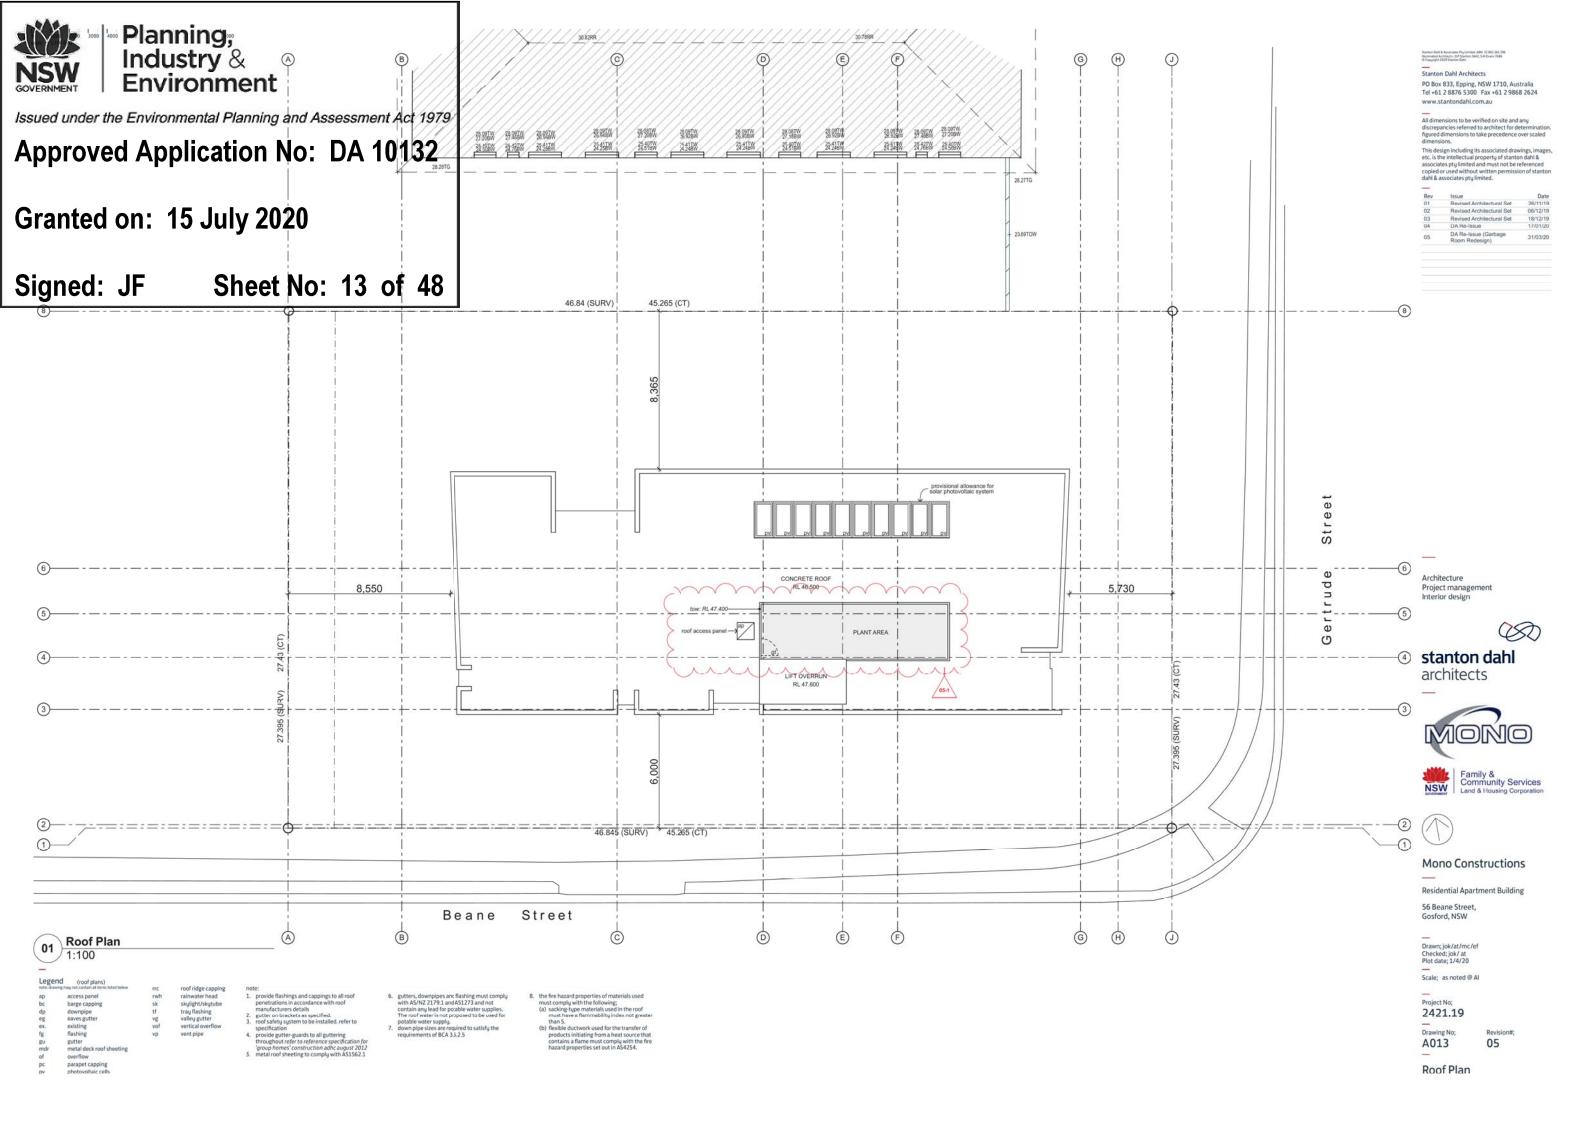



North Elevation 1:100

end									
awit	g may not contain all items listed below	cj	controljoint	flv	fixed louvres	pap(1)	perforated acoustic panel (type)	55(1)	sun shade (type)
	air conditioner condenser	conc.	concrete	gl	ground line	pbd	plasterboard	ts	timber skirting
	ag pipe	cs	coved skirting	gt	gate	pv	photovoltaic cells		
	adjustable louvres	dp	downpipe	hr(1)	handrail (type)	rc	rendered concrete	note:	
	aluminium framed window	drh	door head	ip	insulated panel	rms	raked meta soffit	1. all ha	andrails, balustrades & louvres shown indica
)	balustrade (tupe)	eg	eaves gutter	fly	fixed louvres	rp	render & paint finish	only	refer to detail drawings for clarity.
	barge capping	egl	existing ground line	mc(1)	metal cladding (type)	rs	roller shutter		to engineer's drawings for final co-ordinati
	box gutter	ex.	existing	mdr	metal deck roof	rw	retaining wall		stic panel edges at all major joints (solid lin
	brick header course	f	fixed sash window	nc	non structural column	rwh	rainwater head		sed edges including top (adjoining s/s sill)
	brick on edge	fb(1)	face brickwork (tupe)	ofc	off form concrete	5	sliding sashwindow		om (adjoining skirting) are to include 12x12
	brickwork sill	fcl	finished ceiling level	olv	operable louvres	sc	steel column	alum	inium angle.
	compessed fibre cement	m	finished floor level	p(1)	paint (type)	sl	sliding door		



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Drawing No; Revision A014 04

Elevation (Sht 1 of 4)



East Elevation (Gertrude Street)

fixed louvres ground line gate handrail (type) insulated panel fixed louvres metal cladding (type) metal deck roof non structural column off form concrete operable louvres



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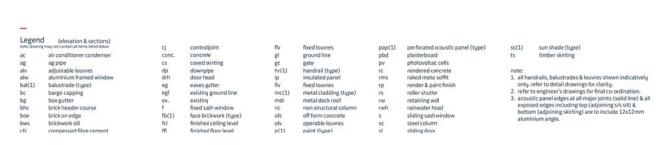
2421.19

05 A015

Elevation (Sht 2 of 4)



South Elevation (Beane Street)





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Stanton Dahl & Associates Physimised Adm 32 002 263 Normated Architects: CJP Stanton 3642, SM Evens 766

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03	Revised Architectural Set	18/12/19
04	DA Re-Issue	17/01/20
	DA Re-Issue (Garbage	

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#### Mono Constructions

Residential Apartment Building

56 Beane Street,

Drawn; jok/at/mc/ef Checked: jok/ at Plot date; 1/4/20 Scale; 1:100 as noted @ Al

Scale; 1:100 as noted @

2421.19

A016

Revision#;

Elevation (Sht 3 of 4)



01 West Elevation





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**Approved Application No: DA 10132** 

Granted on: 15 July 2020

Signed: JF Sheet No: 17 of 48

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#### Mono Constructions

Residential Apartment Building

56 Beane Street, Gosford, NSW

Drawn; jok/at/mc/ef Checked; jok/ at Plot date; 1/4/20

Project No; 2421.19

Drawing No; Revision A017 04

Elevation (Sht 4 of 4)

fiv fixed louvres
gl ground line
gt gate
hr(1) handrail (type)
ip insulated panel
fiv fixed louvres
mc(1) metal cladding (type)
mdr metal cladding (type)
mc non structural column
ofc off form concrete
obv operable louvres
p(1) paint (type)

perforated acoustic panel (type) plasterboard photovoltac cells rendered cancrete raked meta soffit rendere & paint finish roller shutter retaining wall rainwater had sliding sashwindow steel colum sliding door

Stanton Dahl Architects PO Box 833, Epping, NSW 1710, Australia Tel +61 2 8876 5300 Fax +61 2 9868 2624 Issue Revised Architectural Set Revised Architectural Set Revised Architectural Set DA Re-Issue Architecture Interior design stanton dahl architects **Gertrude Street** MONO **Mono Constructions** Residential Apartment Building 56 Beane Street, Gosford, NSW Drawn; jok/at/mc/ef Checked; jok/ at Plot date; 1/4/20 2421.19

A018

Section (Sht 1 of 2)




**Approved Application No: DA 10132** 

Sheet No: 18 of 48

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#### Mono Constructions

Residential Apartment Building

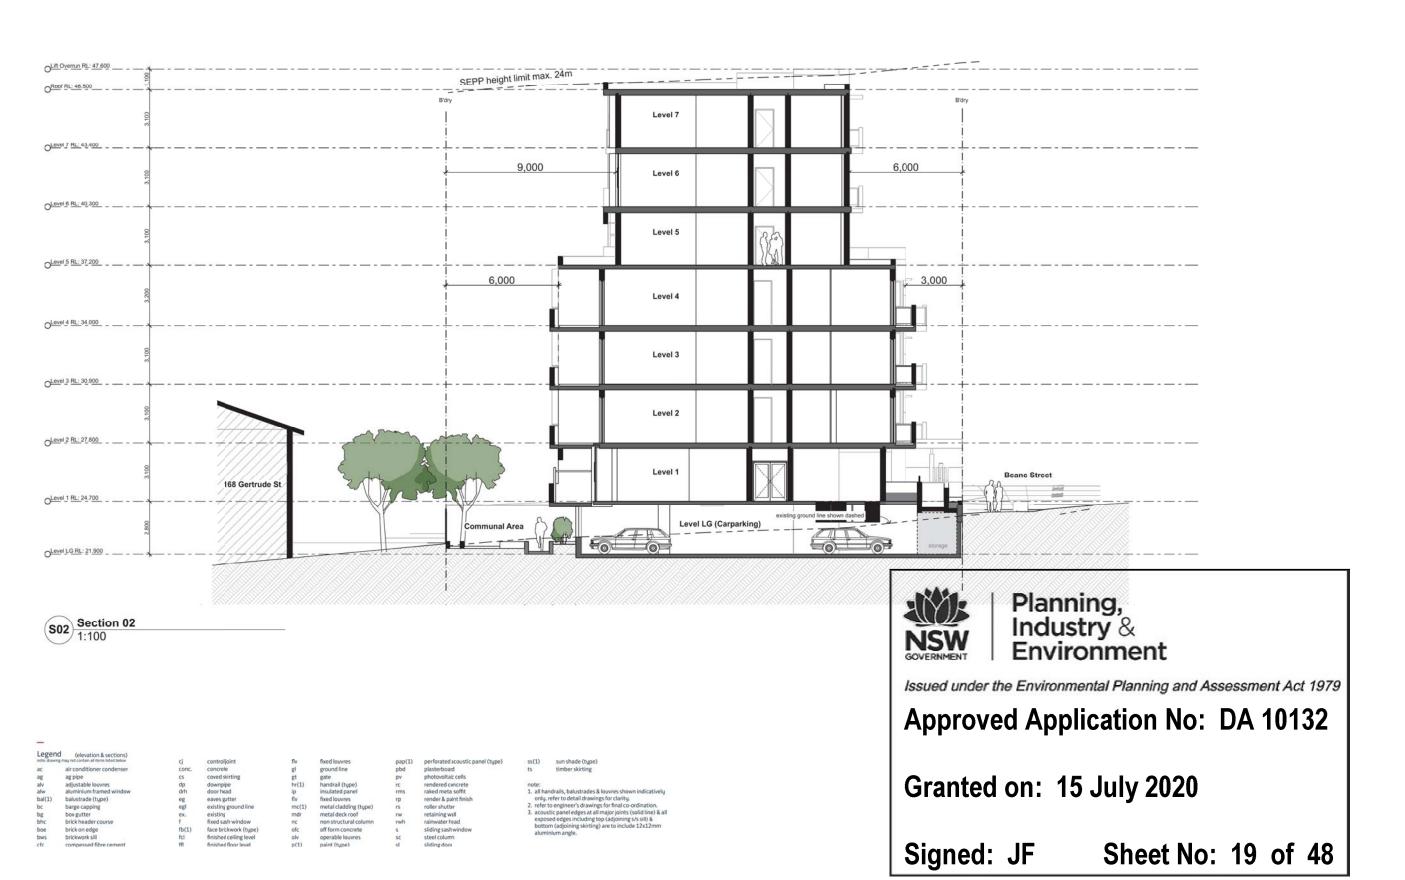56 Beane Street, Gosford, NSW

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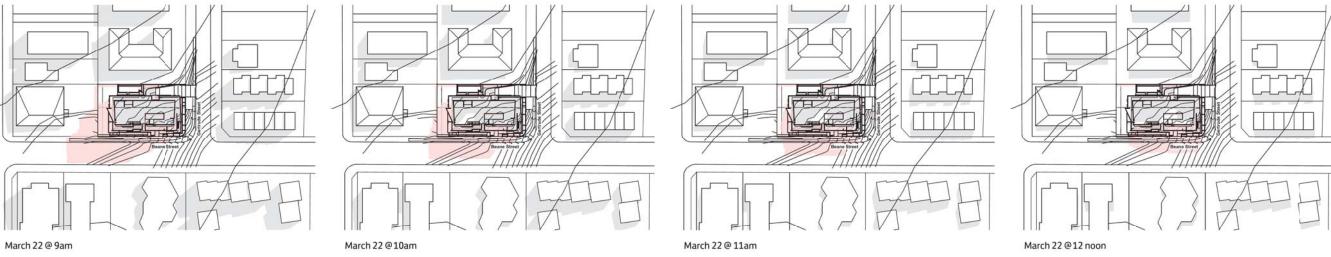
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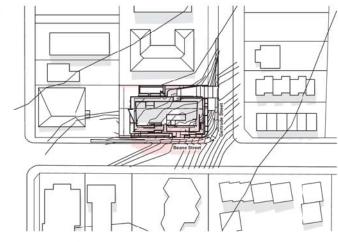
Project No; 2421.19


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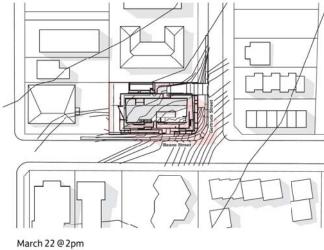
Section (Sht 2 of 2)


# Shadow Diagrams - March







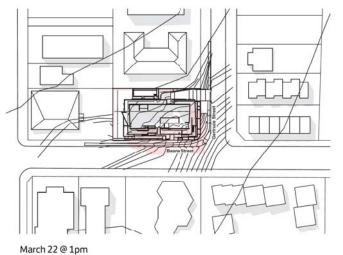

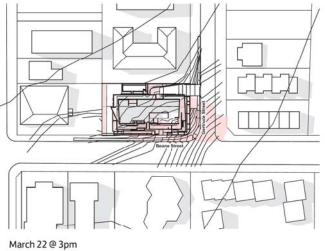

Shadow Diagram March 22



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Residential Apartment Building

56 Beane Street,

Gosford, NSW

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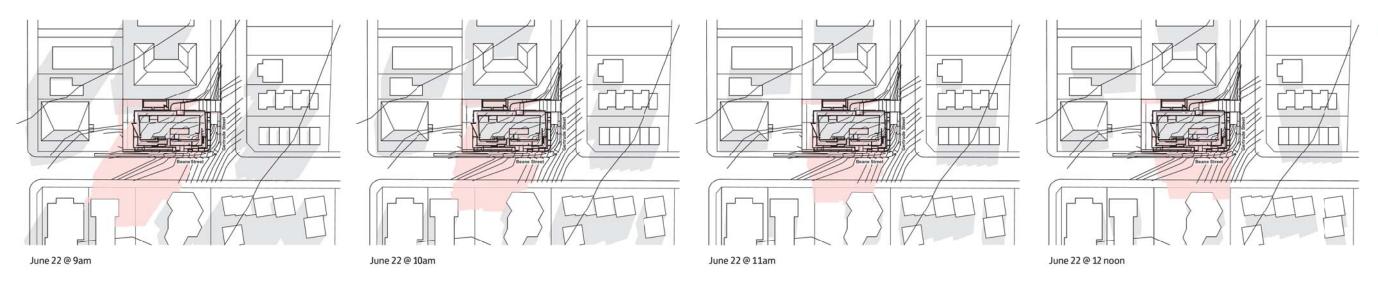
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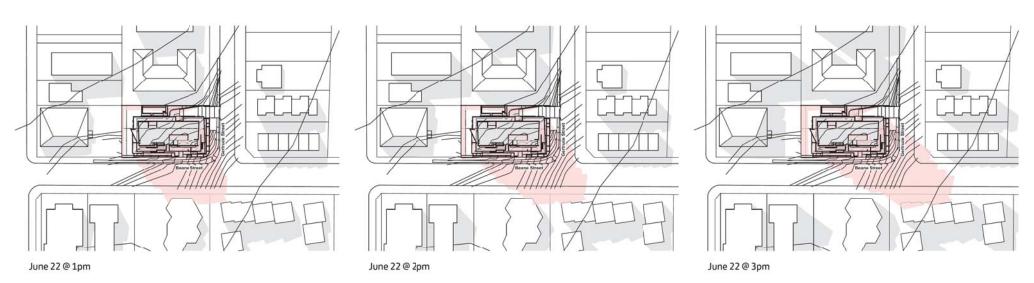
2421.19

Drawing No; A020

Shadow Diagrams (Sht 1 of 3)

## Shadow Diagrams - June





O1 Shadow Diagram June 22



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Residential Apartment Building

56 Beane Street, Gosford, NSW

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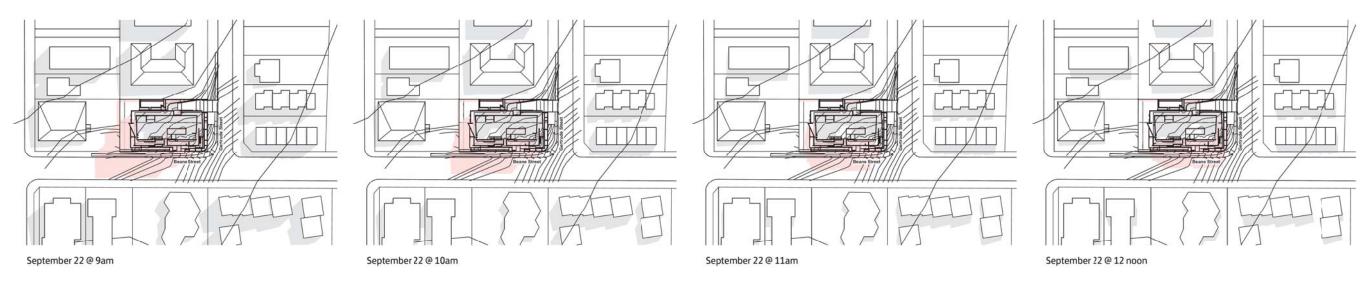
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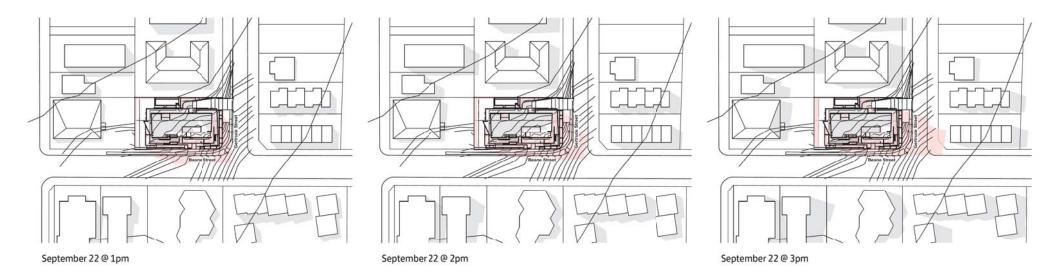
Drawing No; Revision A021 04

Shadow Diagrams (Sht 2 of 3)

Grey area indicates Shadows cast by existing neighbouring properties

## Shadow Diagrams - September





Shadow Diagram September 22



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Residential Apartment Building

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Scale; 1:1000 as noted @ Al

Project No; 2421.19

Drawing No; Revisi A022 04

Shadow Diagrams (Sht 3 of 3)






Shadow Analysis (view from sun - June 22)

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**Approved Application No: DA 10132** 



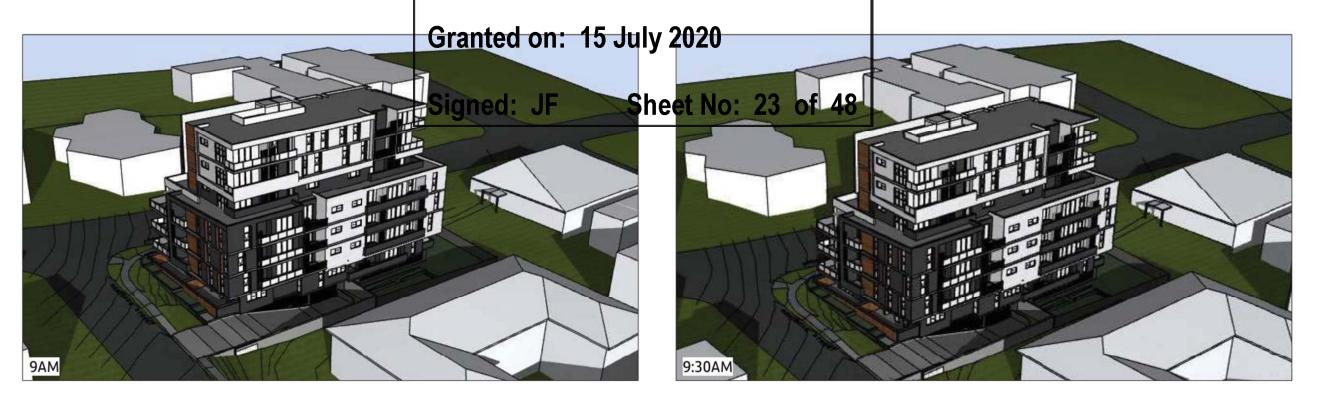



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Architecture Project management Interior design









## Mono Constructions

Residential Apartment Building

56 Beane Street,

Gosford, NSW

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Scale; as noted @ Al

Project No; 2421.19

Drawing No; Re A023 0


Shadow Analysis (view from sun - sht 1 of 2)



Shadow Analysis (view from sun - June 22)

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#### Mono Constructions

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Drawing No; Revi

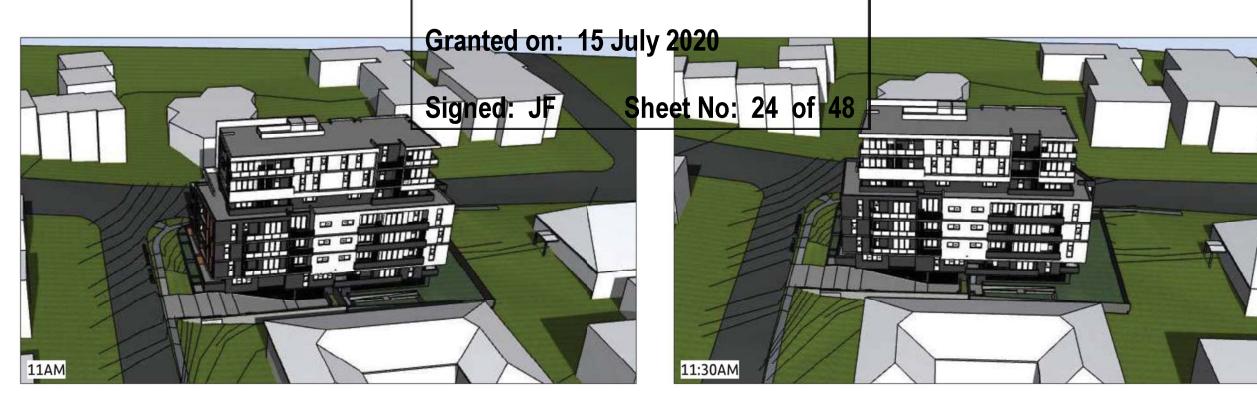Shadow Analysis (view from sun - sht 2 of 2)